


EXISTING GROUND FLOOR PLAN
SCALE 1:50

NOTES: All detailed measurements are approximate.

NOTES: All measurements of neighbouring properties are approximate including garden levels and will be subject to Party Wall Matters.

REV.	DATE	NOTES	CLIENT	PROJECT ADDRESS	SCALE	DRAWING NO.
			AJ	RIBBLESDALE ROAD, SW16	1:50@A3	P- 1
					DATE	
					10-09-2020	
				DRAWING TITLE	<p>Meters @ 1:50@ A3</p>	
				PROPOSED GROUND FLOOR PLAN		

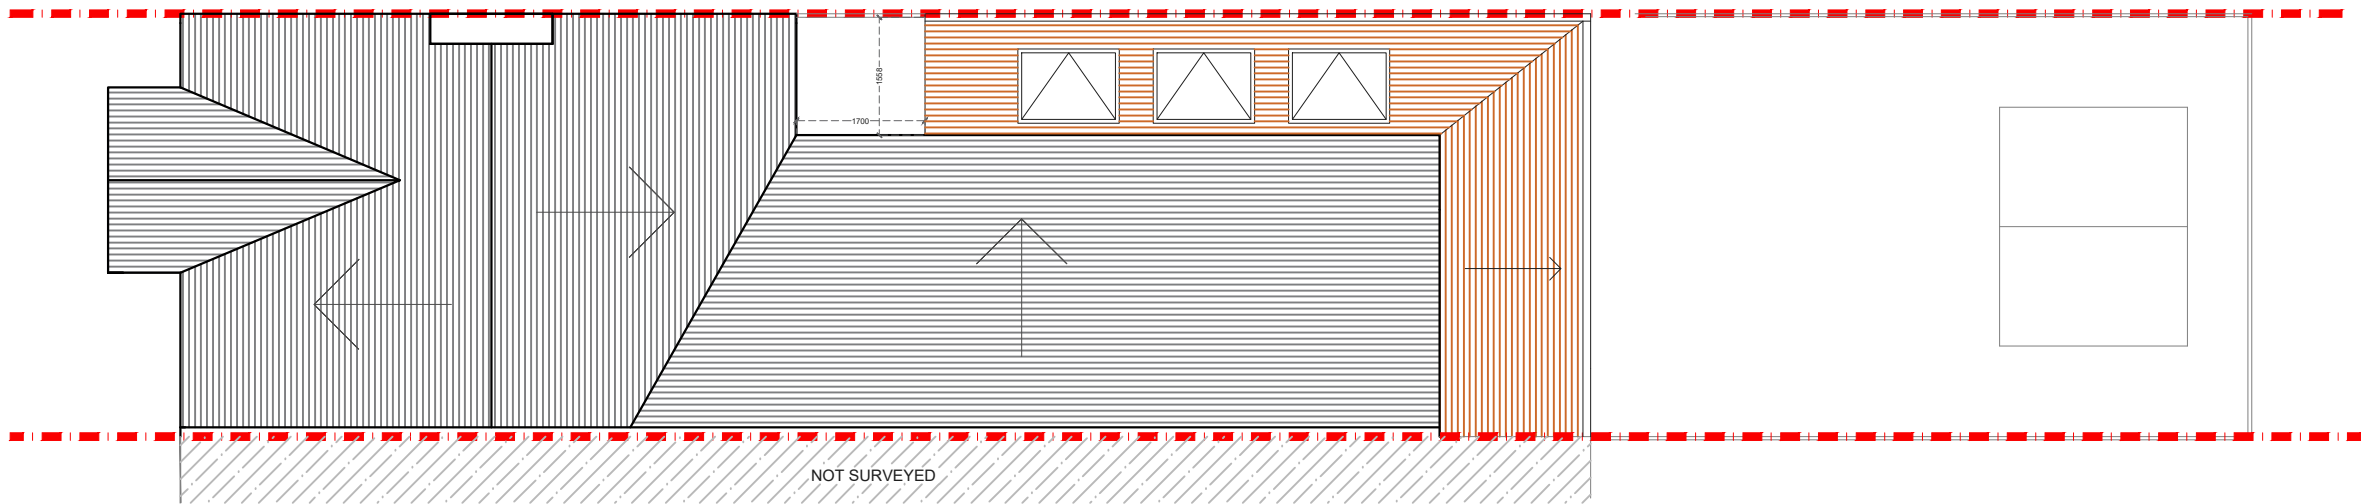

PROPOSED ROOF PLAN
SCALE 1:100

NOTES: All detailed measurements are approximate.
NOTES: All measurements of neighbouring properties are approximate including garden levels and will be subject to Party Wall Matters.

REV.	DATE	NOTES	CLIENT	PROJECT ADDRESS	SCALE	DRAWING NO.
			AJ	RIBBLESDALE ROAD, SW16	1:100@A3	P-2
				DRAWING TITLE	DATE	
				PROPOSED ROOF PLAN	10-09-2020	
					0 1 2 3 4 5 6 7 8 9 10	
					Meters @ 1:100@ A3	


NOTES: All detailed measurements are approximate.

NOTES: All measurements of neighbouring properties are approximate including garden levels and will be subject to Party Wall Matters.

NOTES: All recessed beams assume that the floor thickness is 6 inches. This cannot be confirmed until the opening up work during the build phase.

NOTES: All proposed skylight sizes subject to final onsite measurements by chosen contractor.

NOTES: Structural calculations and depth of all foundations for the new extension is to be confirmed by the building control officer on site taking soil type and nearby trees into account prior to pouring concrete and commencement on site.

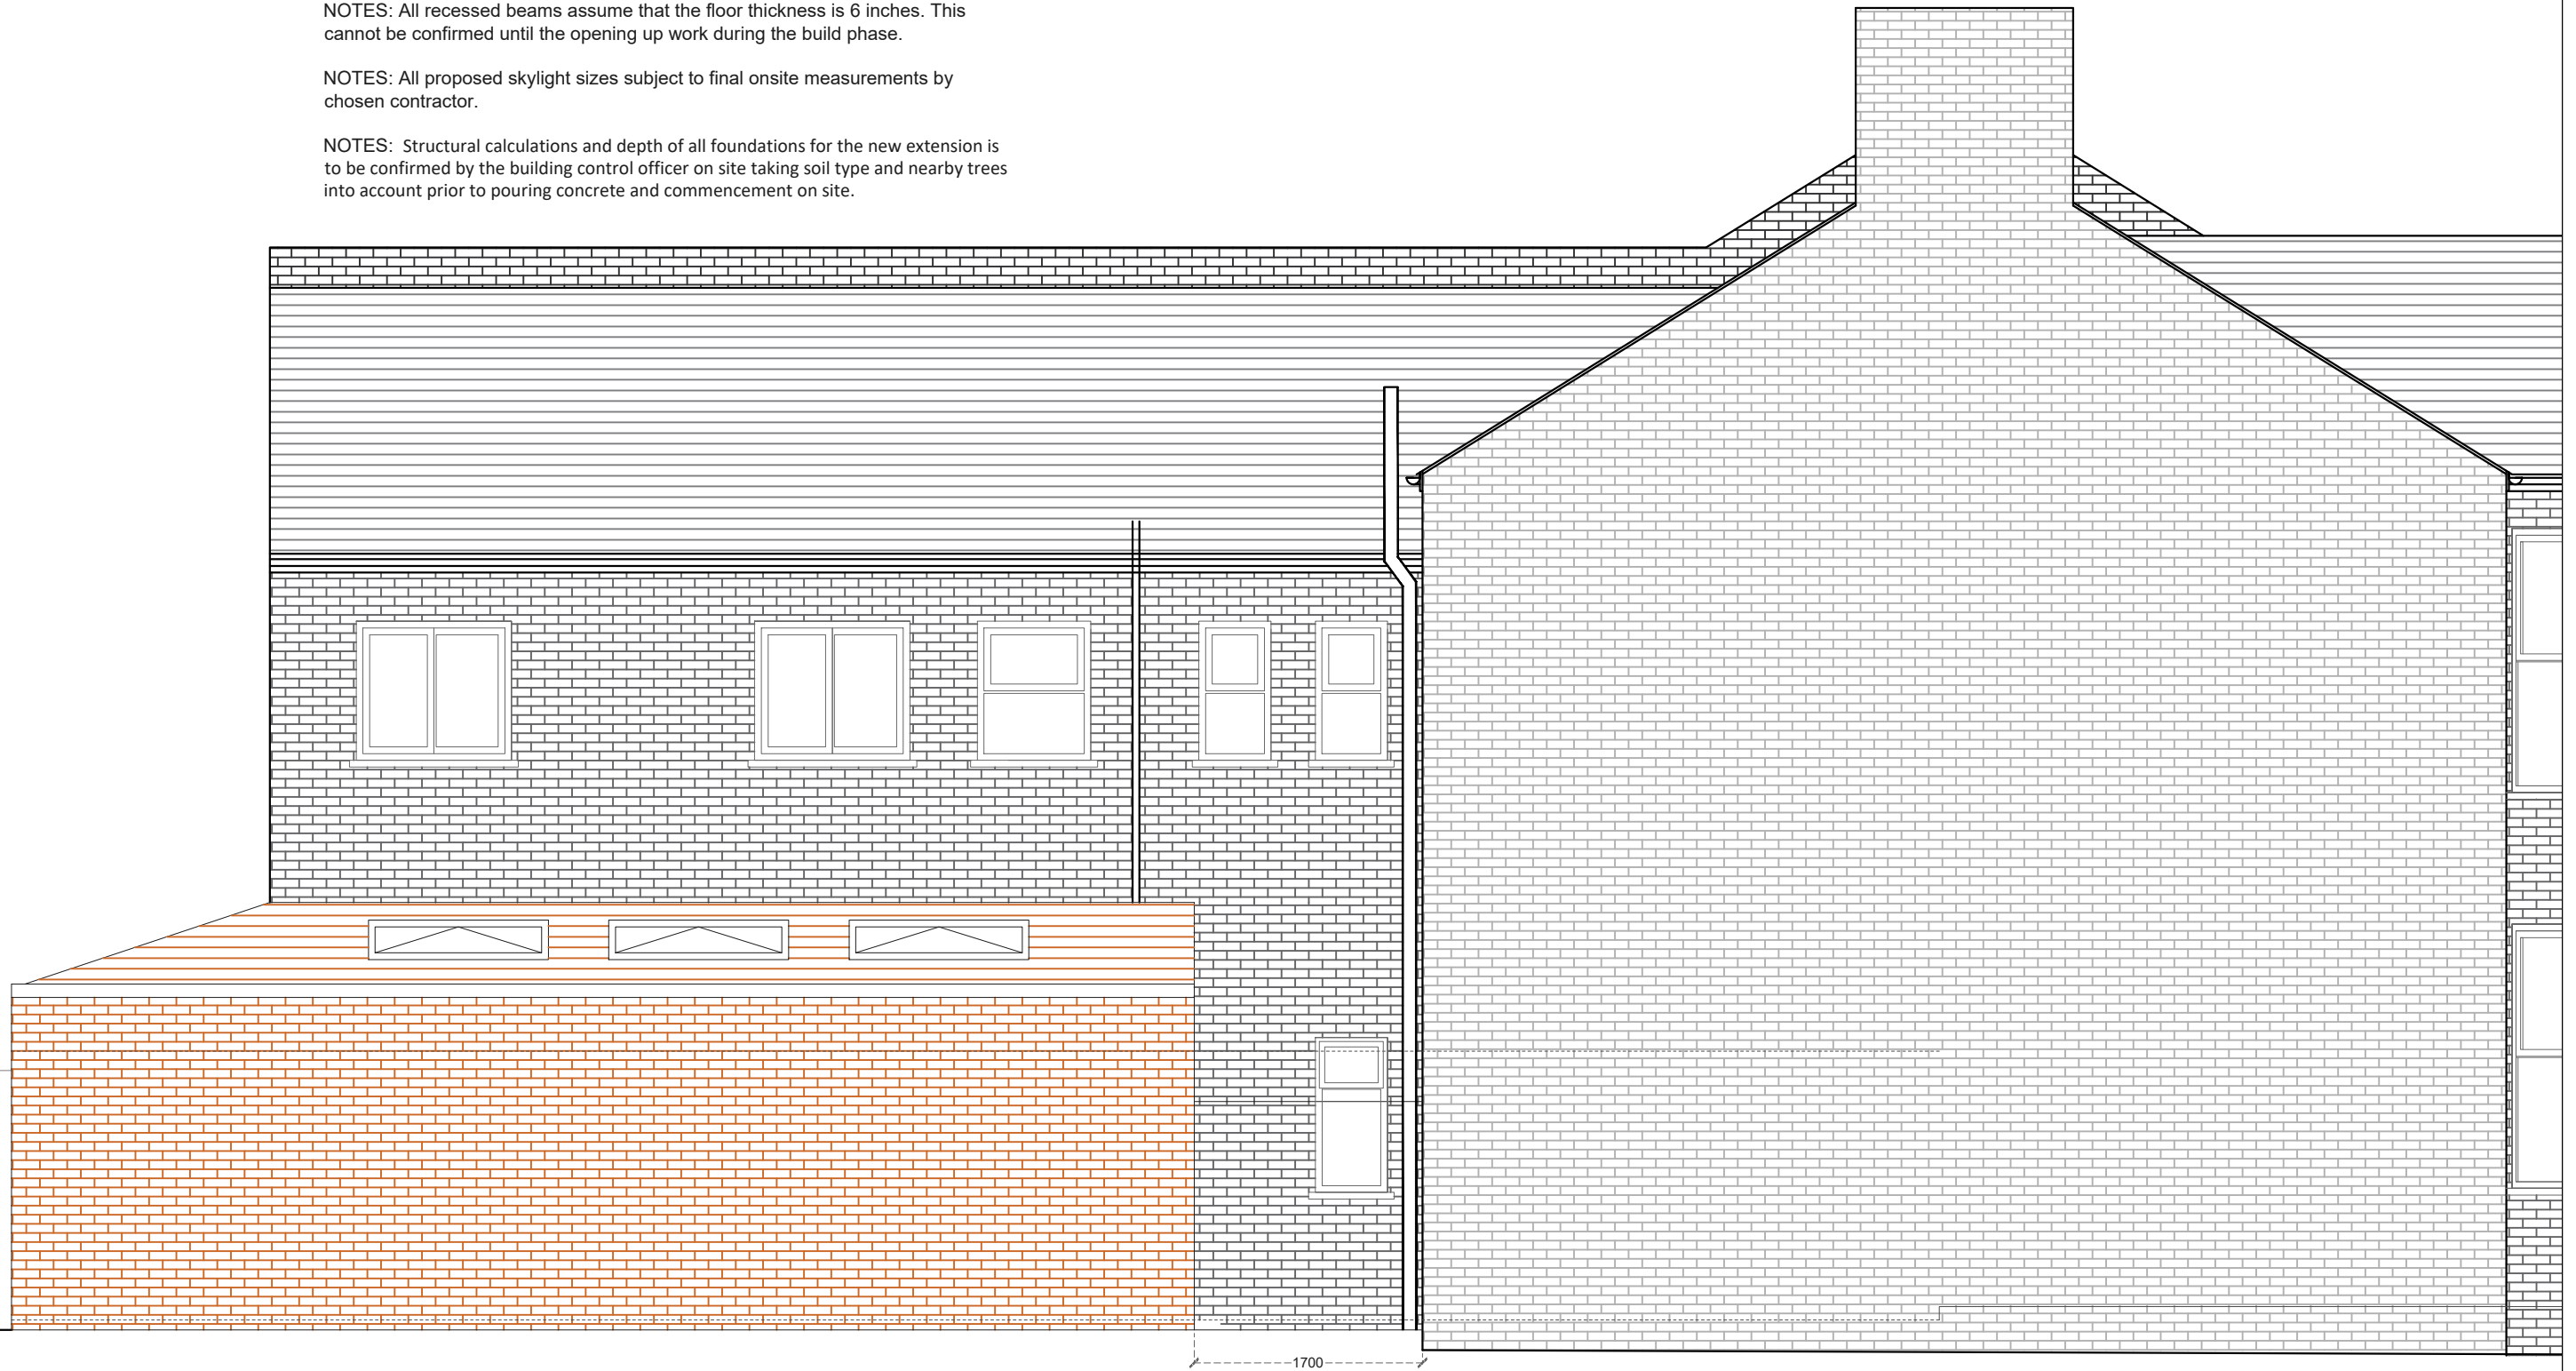

PROPOSED SIDE ELEVATION
SCALE 1:50

REV.	DATE	NOTES	CLIENT	PROJECT ADDRESS	SCALE	DRAWING NO.
			AJ	RIBBLESDALE ROAD, SW16	1:50@A3	P- 3
				DRAWING TITLE	DATE	
				PROPOSED SIDE ELEVATION	10-09-2020	
					0 0.5 1 1.5 2 2.5 3 3.5 4 4.5 5	
					Meters @ 1:50@ A3	