

NOTES: All detailed measurements are approximate.

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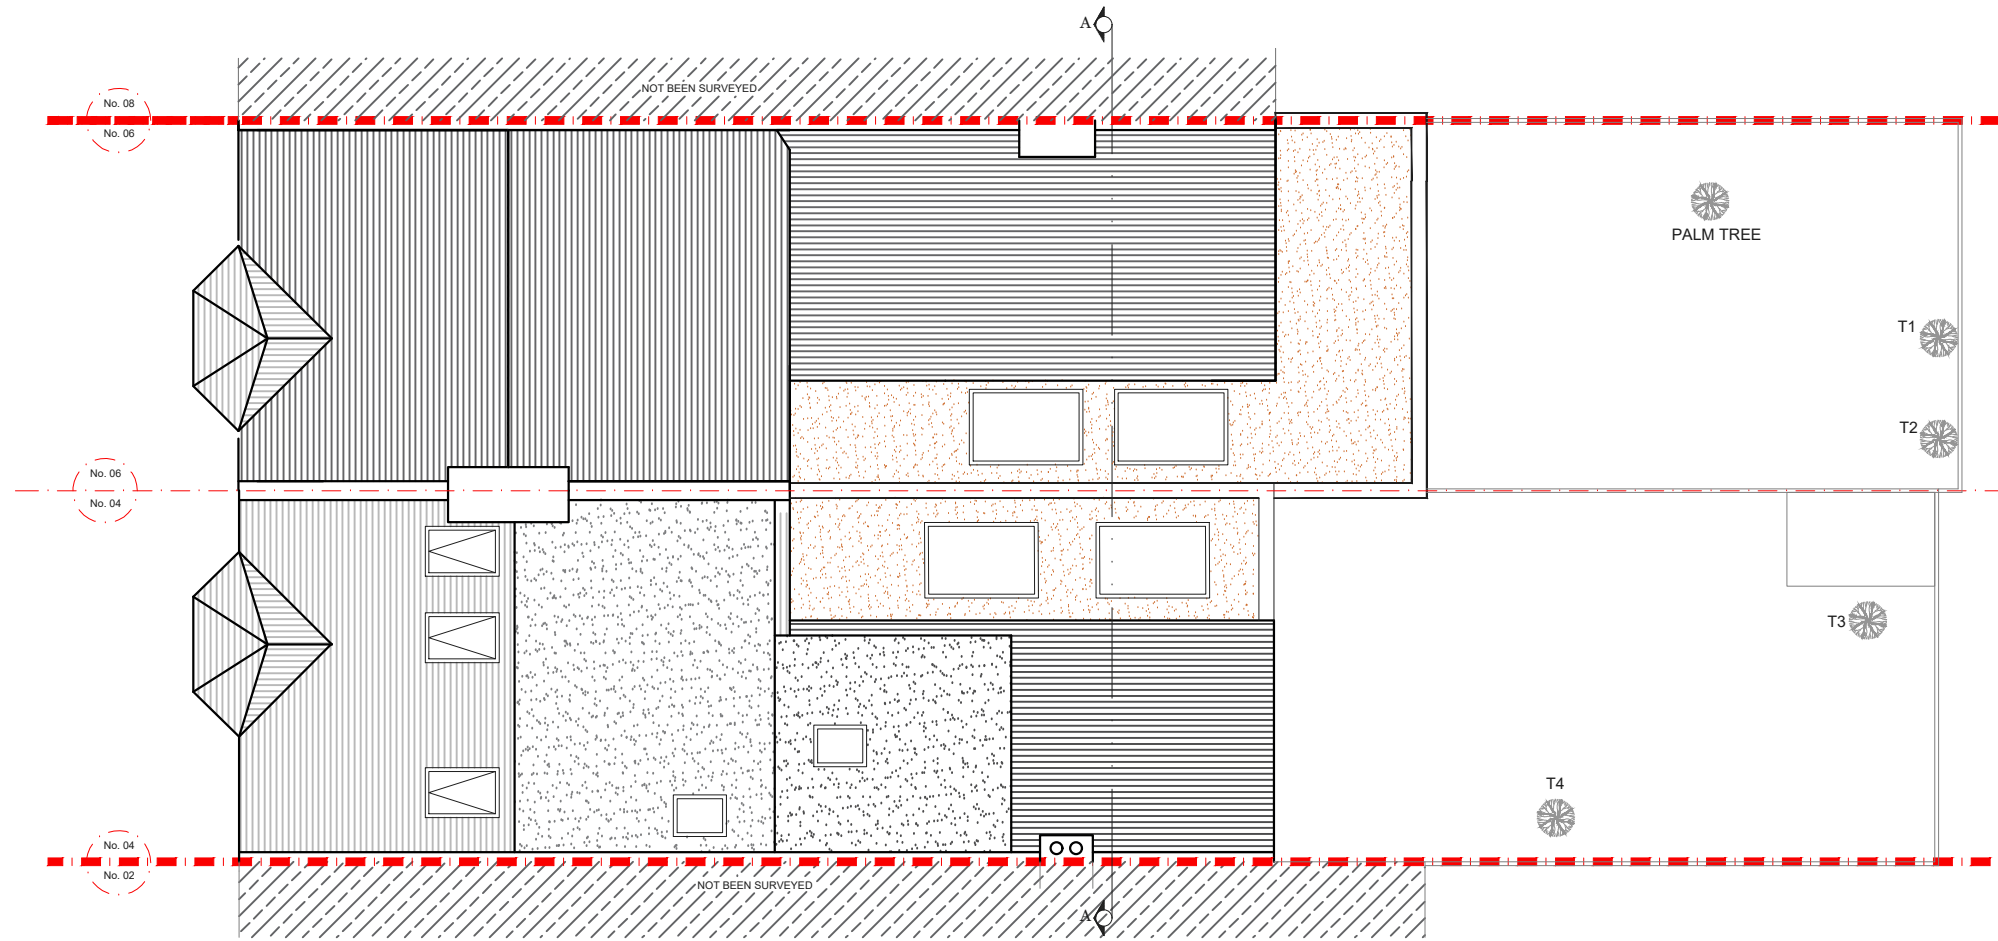
NOTES: All recessed beams assume that the floor thickness is 6 inches. This cannot be confirmed until the opening up work during the build phase.

NOTES: All proposed skylight sizes subject to final onsite measurements by chosen contractor.

NOTES: Structural calculations and depth of all foundations for the new extension is to be confirmed by the building control officer on site taking soil type and nearby trees into account prior to pouring concrete and commencement on site.

PROPOSED GROUND FLOOR PLAN
SCALE 1:50

REV.	DATE	NOTES	CLIENT	PROJECT ADDRESS	SCALE	DRAWING NO.
			JB & CW	DOUGLAS ROAD, NW6	1:50@A3	P- 01
					DATE	
					29-09-2020	
				DRAWING TITLE	0 0.5 1 1.5 2 2.5 3 3.5 4 4.5 5	
				PROPOSED GROUND FLOOR PLAN	Meters @ 1:50@ A3	



PROPOSED ROOF PLAN
SCALE 1:100

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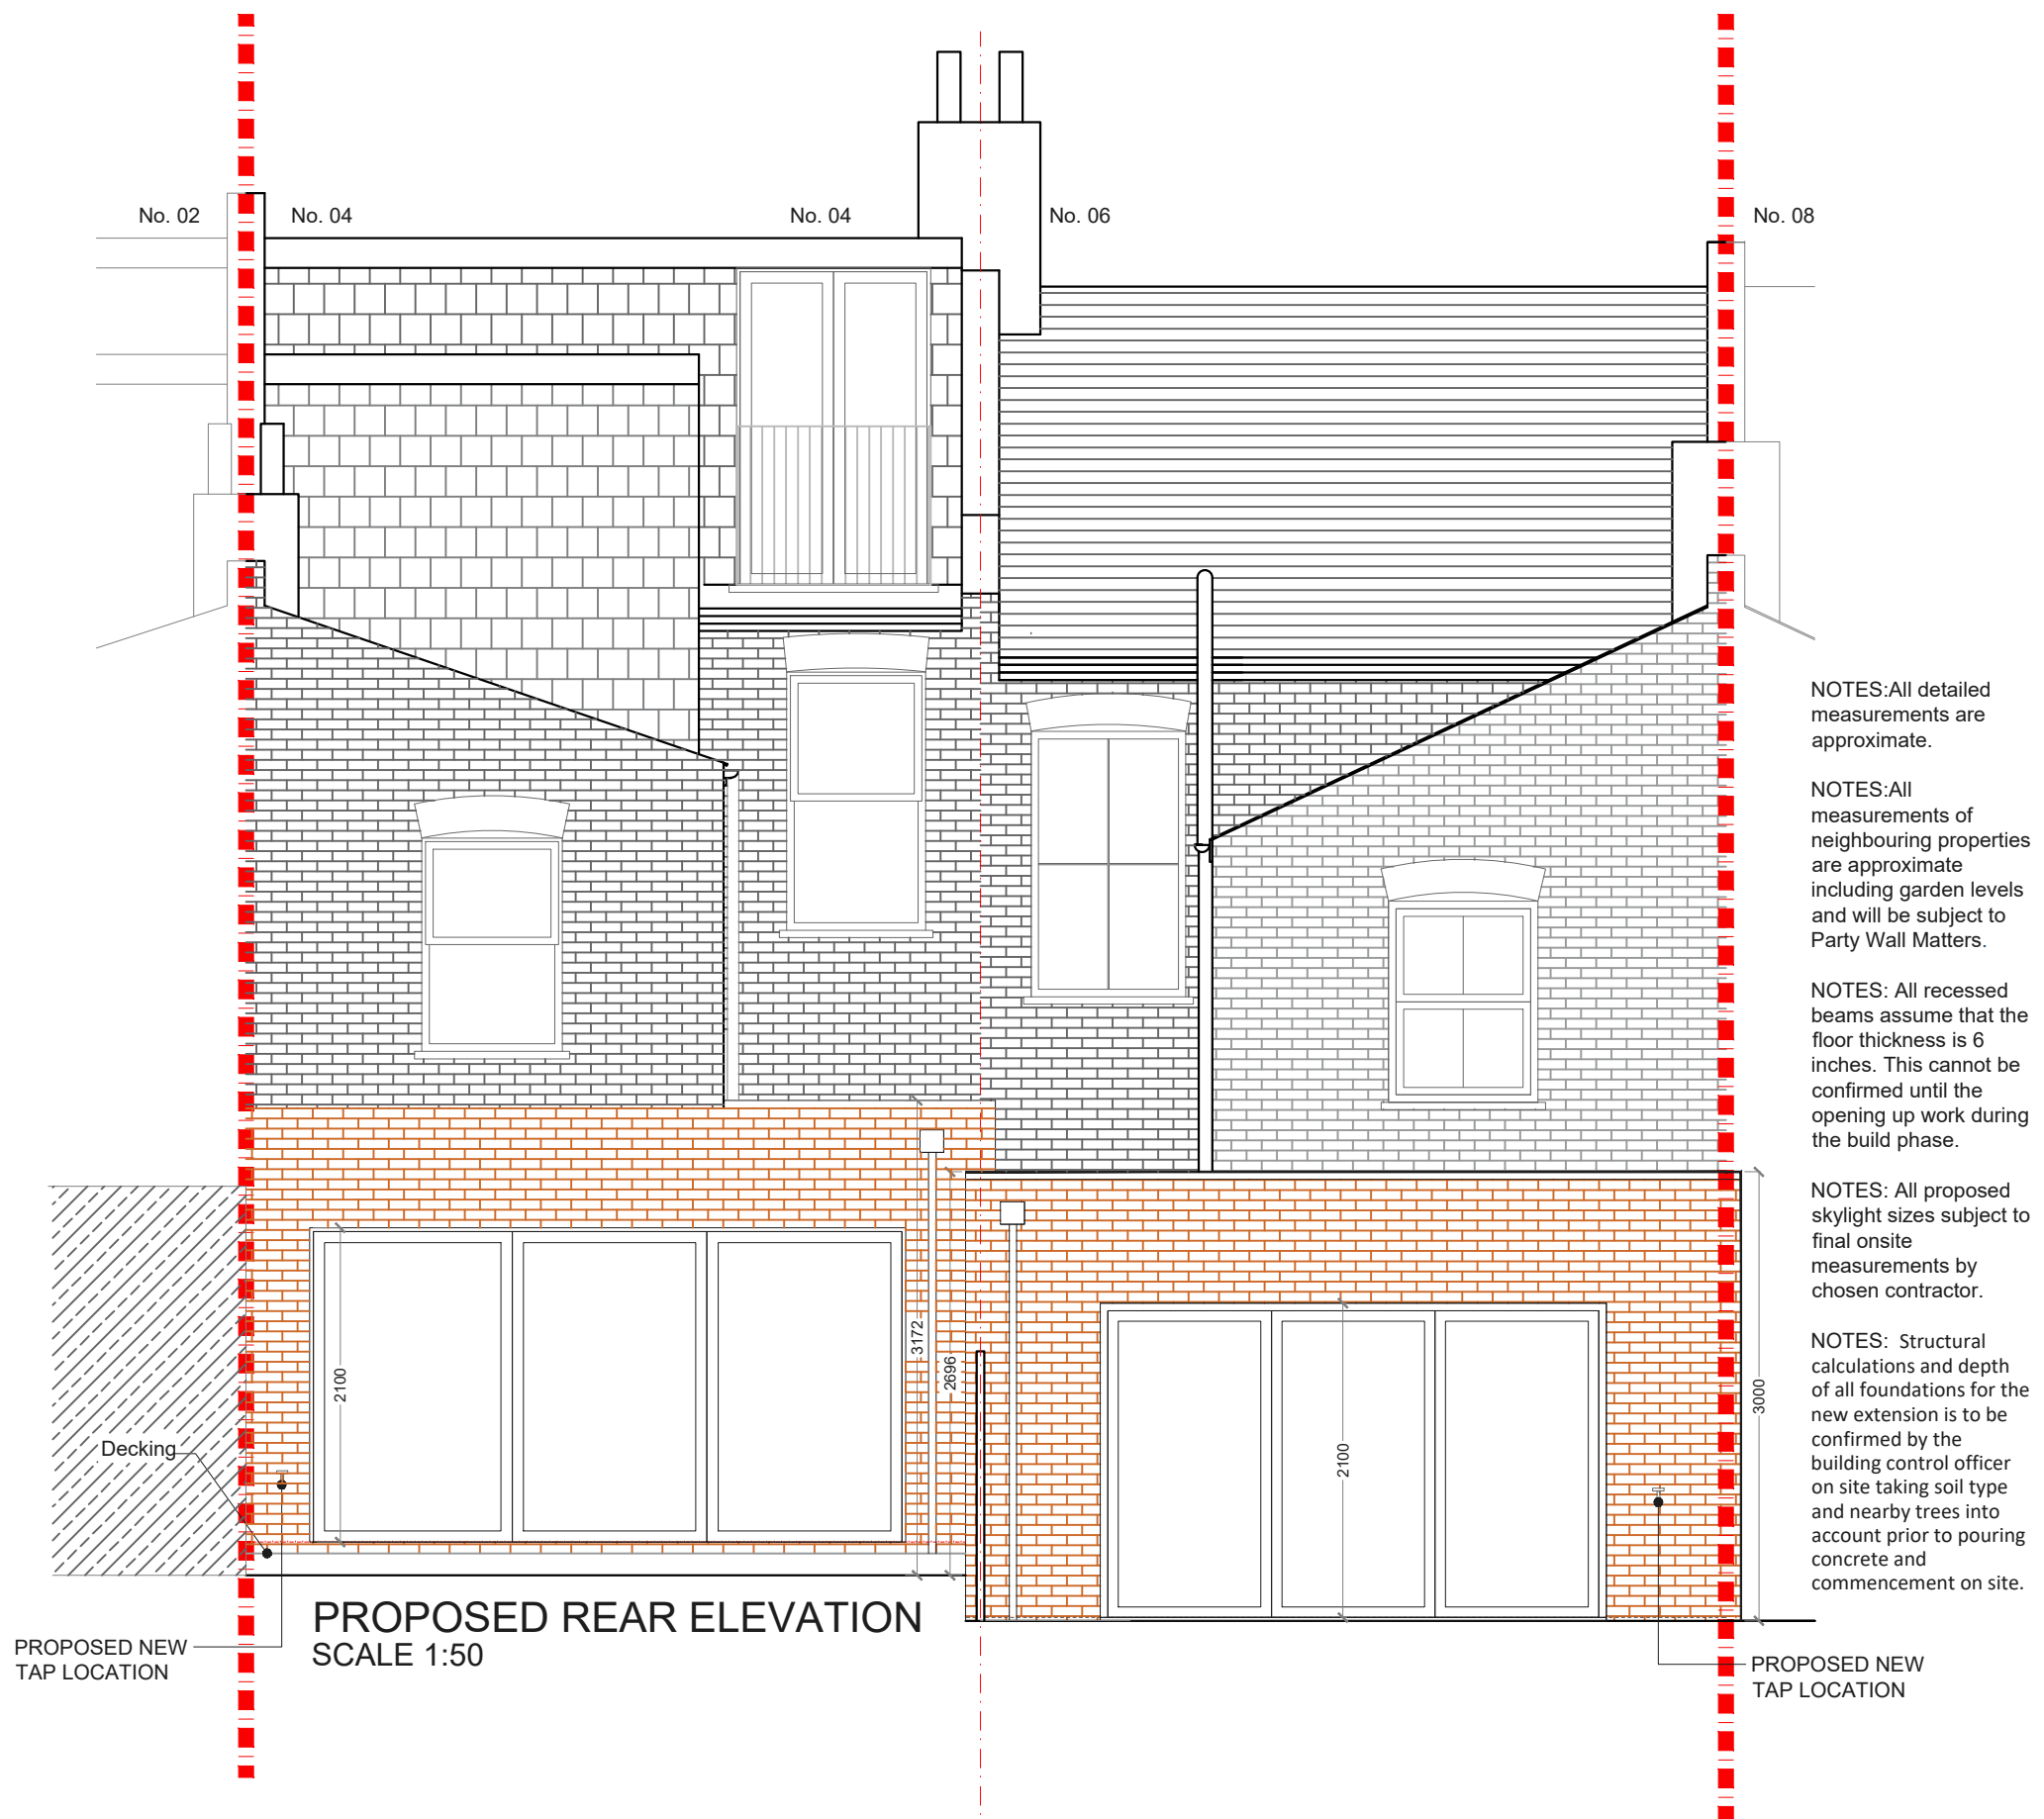
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			CLIENT	PROJECT ADDRESS	SCALE	DRAWING NO.
			JB & CW	DOUGLAS ROAD, NW6	1:100@A3	P- 02
				DRAWING TITLE	DATE	
				PROPOSED ROOF PLAN	29-09-2020	
					0 1 2 3 4 5 6 7 8 9 10	
					Meters @ 1:100@ A3	



	CLIENT	PROJECT ADDRESS	SCALE	DRAWING NO.
	JB & CW	DOUGLAS ROAD, NW6	1:50@A3	P- 03
			DATE	
			29-09-2020	
		DRAWING TITLE	0 0.5 1 1.5 2 2.5 3 3.5 4 4.5 5	
		PROPOSED REAR ELEVATIONS	Meters @ 1:50@ A3	